


LEGEND

- ELECTRICAL SERVICES SWITCHBOARD.
- SWITCHBOARD / CONTROL PANEL NOT PROVIDED AS PART OF THE ELECTRICAL SUBCONTRACT.
- SINGLE POWER OUTLET.
- DOUBLE POWER OUTLET.
- USB DOUBLE POWER OUTLET C/W USB CHARGER.
- DRINK FOUNTAIN OUTLET.
- SPECIAL PURPOSE POWER OUTLET.
- SINGLE PHASE ISOLATOR.
- THREE PHASE ISOLATOR.
- JUNCTION BOX.
- x DENOTES CONDUIT TYPE.
- PIT x □ ELECTRICAL PIT, TYPE AS NOTED.
- HD HAND DRYER CONNECTION.
- PD LIGHTING PRESENCE DETECTOR SWITCH.
- LCP LIGHTING CONTROL PANEL.
- SPx BMS SWITCH PANEL, TYPE AS NOTED.
- ONE-WAY LIGHT SWITCH.
- TWO-WAY LIGHT SWITCH.
- MANUAL DALI POT DIMMER.
- CIRCUIT LINE.
- SWITCH LINE.
- DB-x - Py POWER CIRCUIT DESIGNATION. DENOTES DB AND CIRCUIT.
- ELECTRICAL EQUIPMENT AS NOTED.
- RK OUTLET MOUNTED IN RECESS KIT.
- HI HDMI OUTLET.
- RJ45 COMMUNICATIONS OUTLET.
- CR ACCESS CONTROL CARD READER.
- ES ACCESS CONTROL DOOR ELECTRIC STRIKE.
- LIW ACCESS CONTROL LIFT INTERFACE MODULE.
- Security DIRECTIONAL MOTION DETECTOR.
- Security PIEZO SIREN.
- PA HORN / HOOTER.
- RECESSED PA MULTI-TAP CONE SPEAKER.
- SURFACE MOUNTED PA MULTI-TAP CONE SPEAKER.
- M1 EXISTING RETAIL METER.
- M2 PRIVATE METER.
- C1 CONTACTOR C1.
- R1 SOLAR RELAY.
- DL SOLAR DATA LOGGER.
- GSD GRID SIGNALING DEVICE.

LEGEND

- FUSE.
- SINGLE PHASE.
- THREE PHASE.
- CURRENT TRANSFORMER C/W REMOVABLE LINK.
- FUSE LINK.
- COMBINED FUSE SWITCH.
- CIRCUIT BREAKER.
- ISOLATOR.
- RESIDUAL CURRENT DEVICE.
- CONTACTOR - NORMALLY OPEN.
- CONTACTOR - NORMALLY CLOSED.
- REFER TO DETAIL NOTED FOR THE AREA SHOWN HATCHED. ADDITIONAL OUTLETS & FITTINGS MAY BE SHOWN ON DETAIL.
- E1: GENERAL RECESSED LED EMERGENCY LIGHT.
- E2: GENERAL WALL MOUNTED LED EMERGENCY LIGHT.
- E3: WEATHERPROOF WALL MOUNTED LED EMERGENCY LIGHT.
- E4: GENERAL SURFACE MOUNTED LED EMERGENCY LIGHT. BLACK.
- E5: GENERAL SURFACE MOUNTED LED EMERGENCY LIGHT. WHITE.
- EX: EMERGENCY LED EXIT LIGHT.
- EX WP: WEATHERPROOF EMERGENCY LED EXIT LIGHT.
- L1: 600 x 600 T-BAR MOUNTED LED FLAT PANEL.
- L2: 300 x 1200 T-BAR MOUNTED LED FLAT PANEL.
- L3: 1200 LONG SURFACE LED BATTEN C/W SENSOR.
- L4: GROUND LEVEL CIRCULATION SURFACE MOUNTED DOWNLIGHT.
- L5: RECESSED AMENITY LED DOWNLIGHT.
- L6: SUSPENDED LINEAR EXTRUSION LIGHT.
- L7: SUSPENDED TRACK LIGHTING.
- L8: LEVEL 1 CIRCULATION RECESSED DOWNLIGHT.
- L9: INCUBATOR PENDANT.
- L10: WALL MOUNTED AREA LIGHT.
- L11: SUSPENDED TRACK LIGHTING.
- L12: RECESSED LED DOWNLIGHT.
- L13: OVERHEAD CUPBOARD STRIP LIGHT.

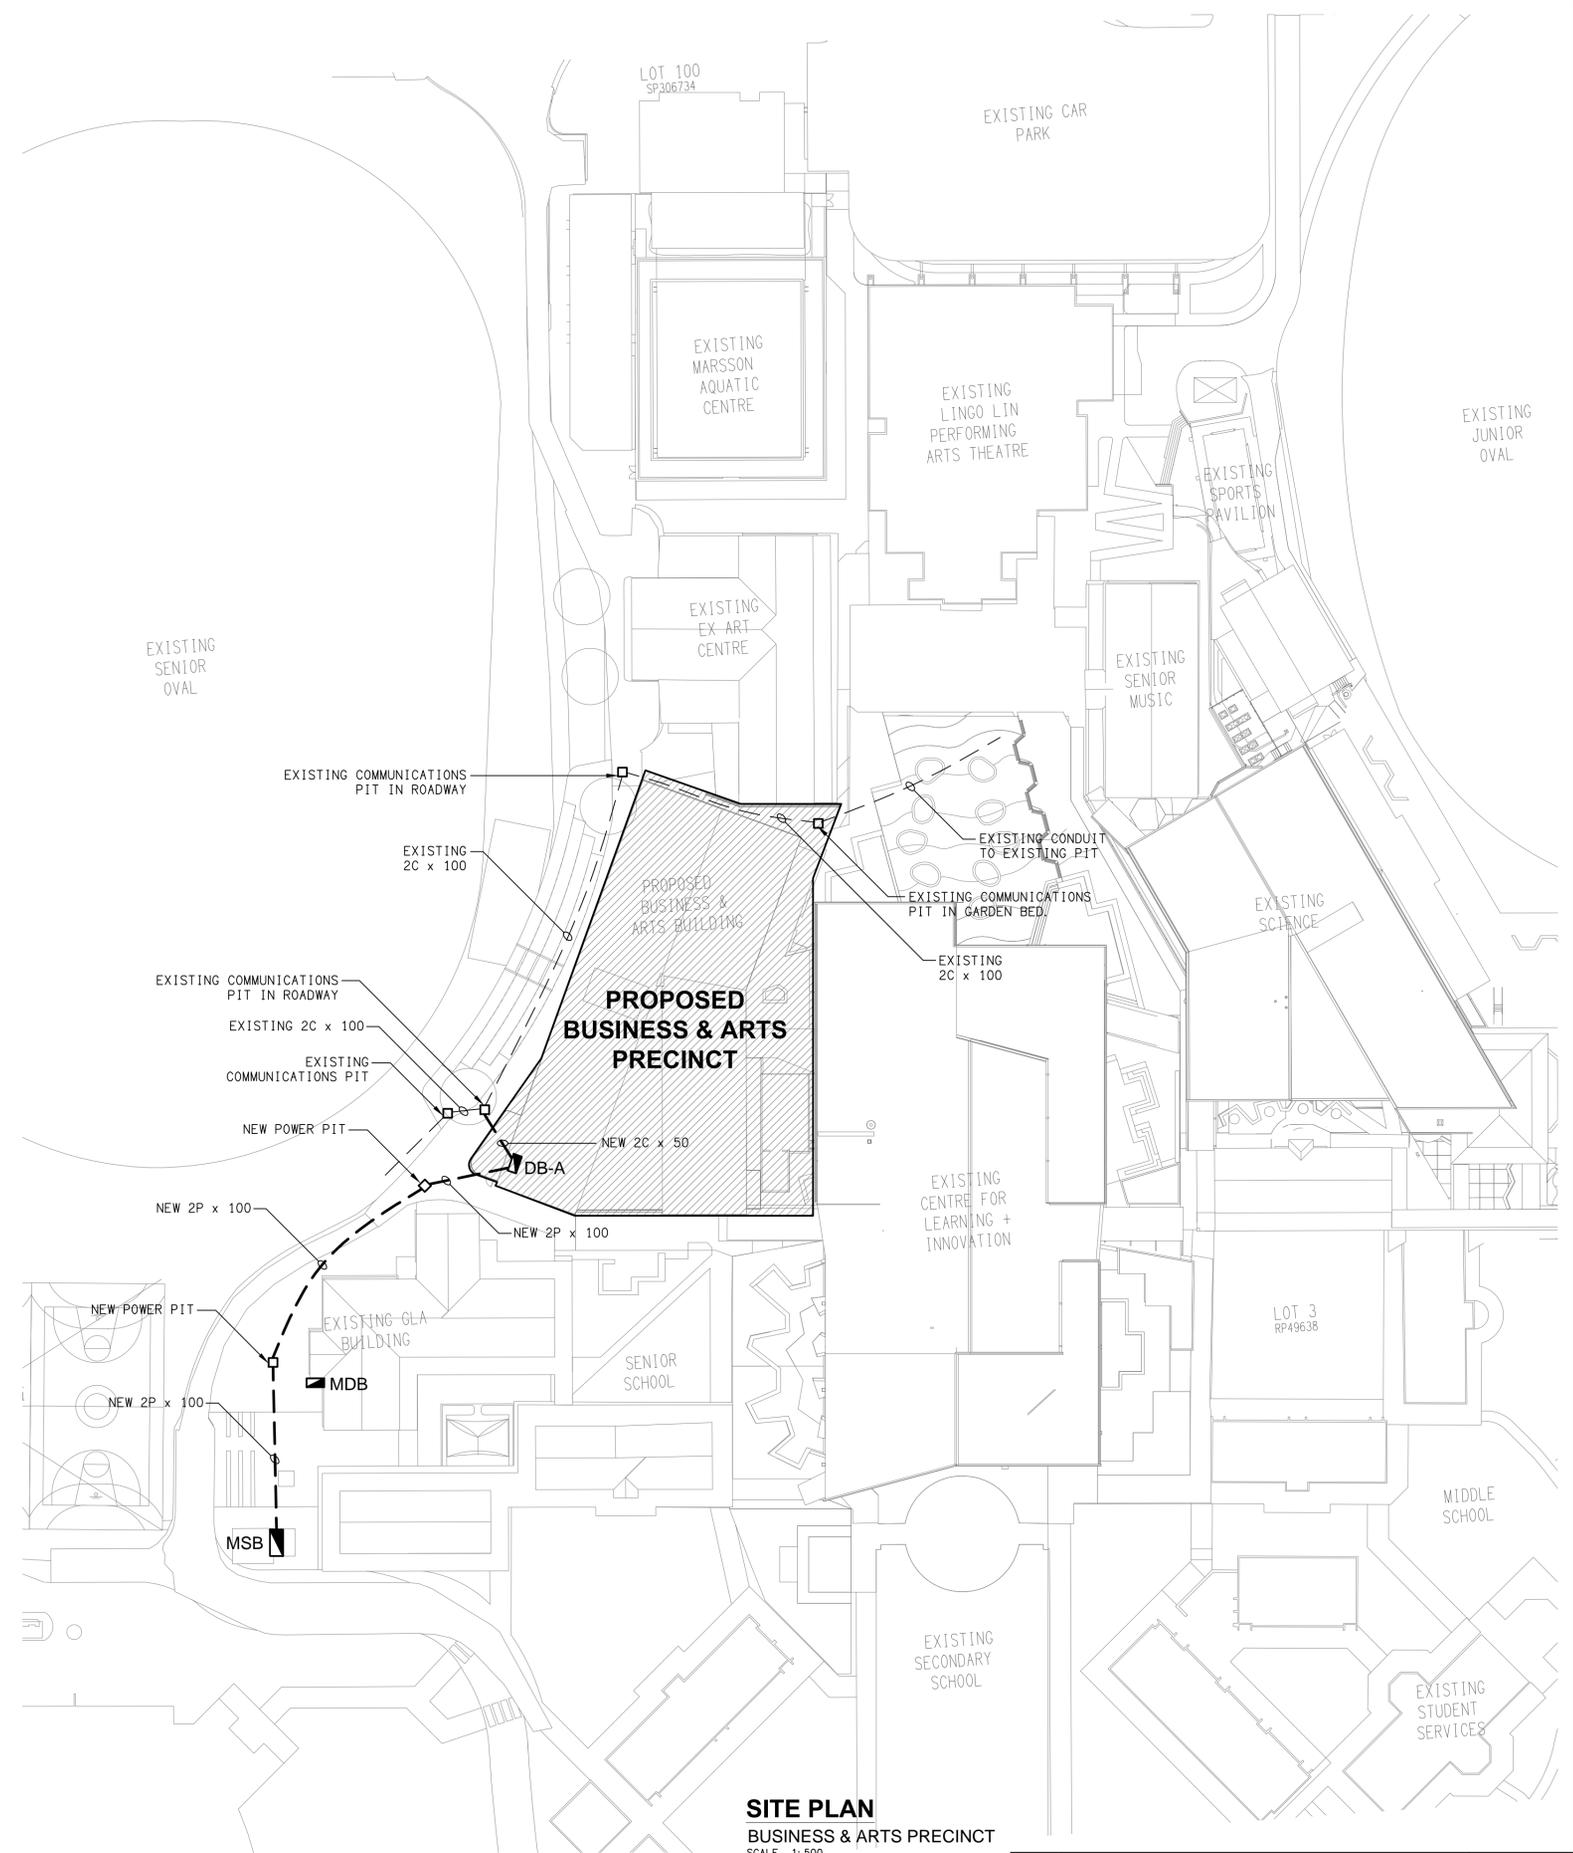

SITE PLAN
BUSINESS & ARTS PRECINCT
SCALE 1:500

ELECTRICAL DESIGN GROUP BRISBANE
PTY LTD
ACN 092 710 793
TRADING AS:
ELECTRICAL DESIGN GROUP

THE COPYRIGHT OF THIS DRAWING
REMAINS THE PROPERTY OF THE
ELECTRICAL DESIGN GROUP.
USE FIGURED DIMENSIONS
IN PREFERENCE TO SCALE.
ALL DIMENSIONS TO BE
VERIFIED ONSITE.

ELECTRICAL DESIGN GROUP
ELECTRICAL BUILDING SERVICES CONSULTANTS
BRISBANE GOLD COAST
P.O. Box 15, Sherwood Q.4075
Phone: (07) 3278 4375
Email: brisbane@edg.net.au
Web: www.edg.net.au

PROJECT:
**ORMISTON COLLEGE
BUSINESS & ARTS PRECINCT**
97 DUNDAS STREET WEST, ORMISTON

A	PRELIMINARY	17/02/2026
REV.	DESCRIPTION:	DATE:
ELECTRICAL SERVICES LEGEND & SITE PLAN		
SCALE: 1:500	AT A1	PROJECT NO: C3666a
		DRAWING NO: E01
		REVISION: A